

SWALLO ARCHITE ARCHITECTURE AND I

RESIDENCE | Floor Porch

1412 Poe Avenue CHARLESTON, SOUTH CAROLINA


MARSHALL I Infill Second


Plot Date 10/17/22 Checked

Drawing Title

Site Plan

Orawing No.

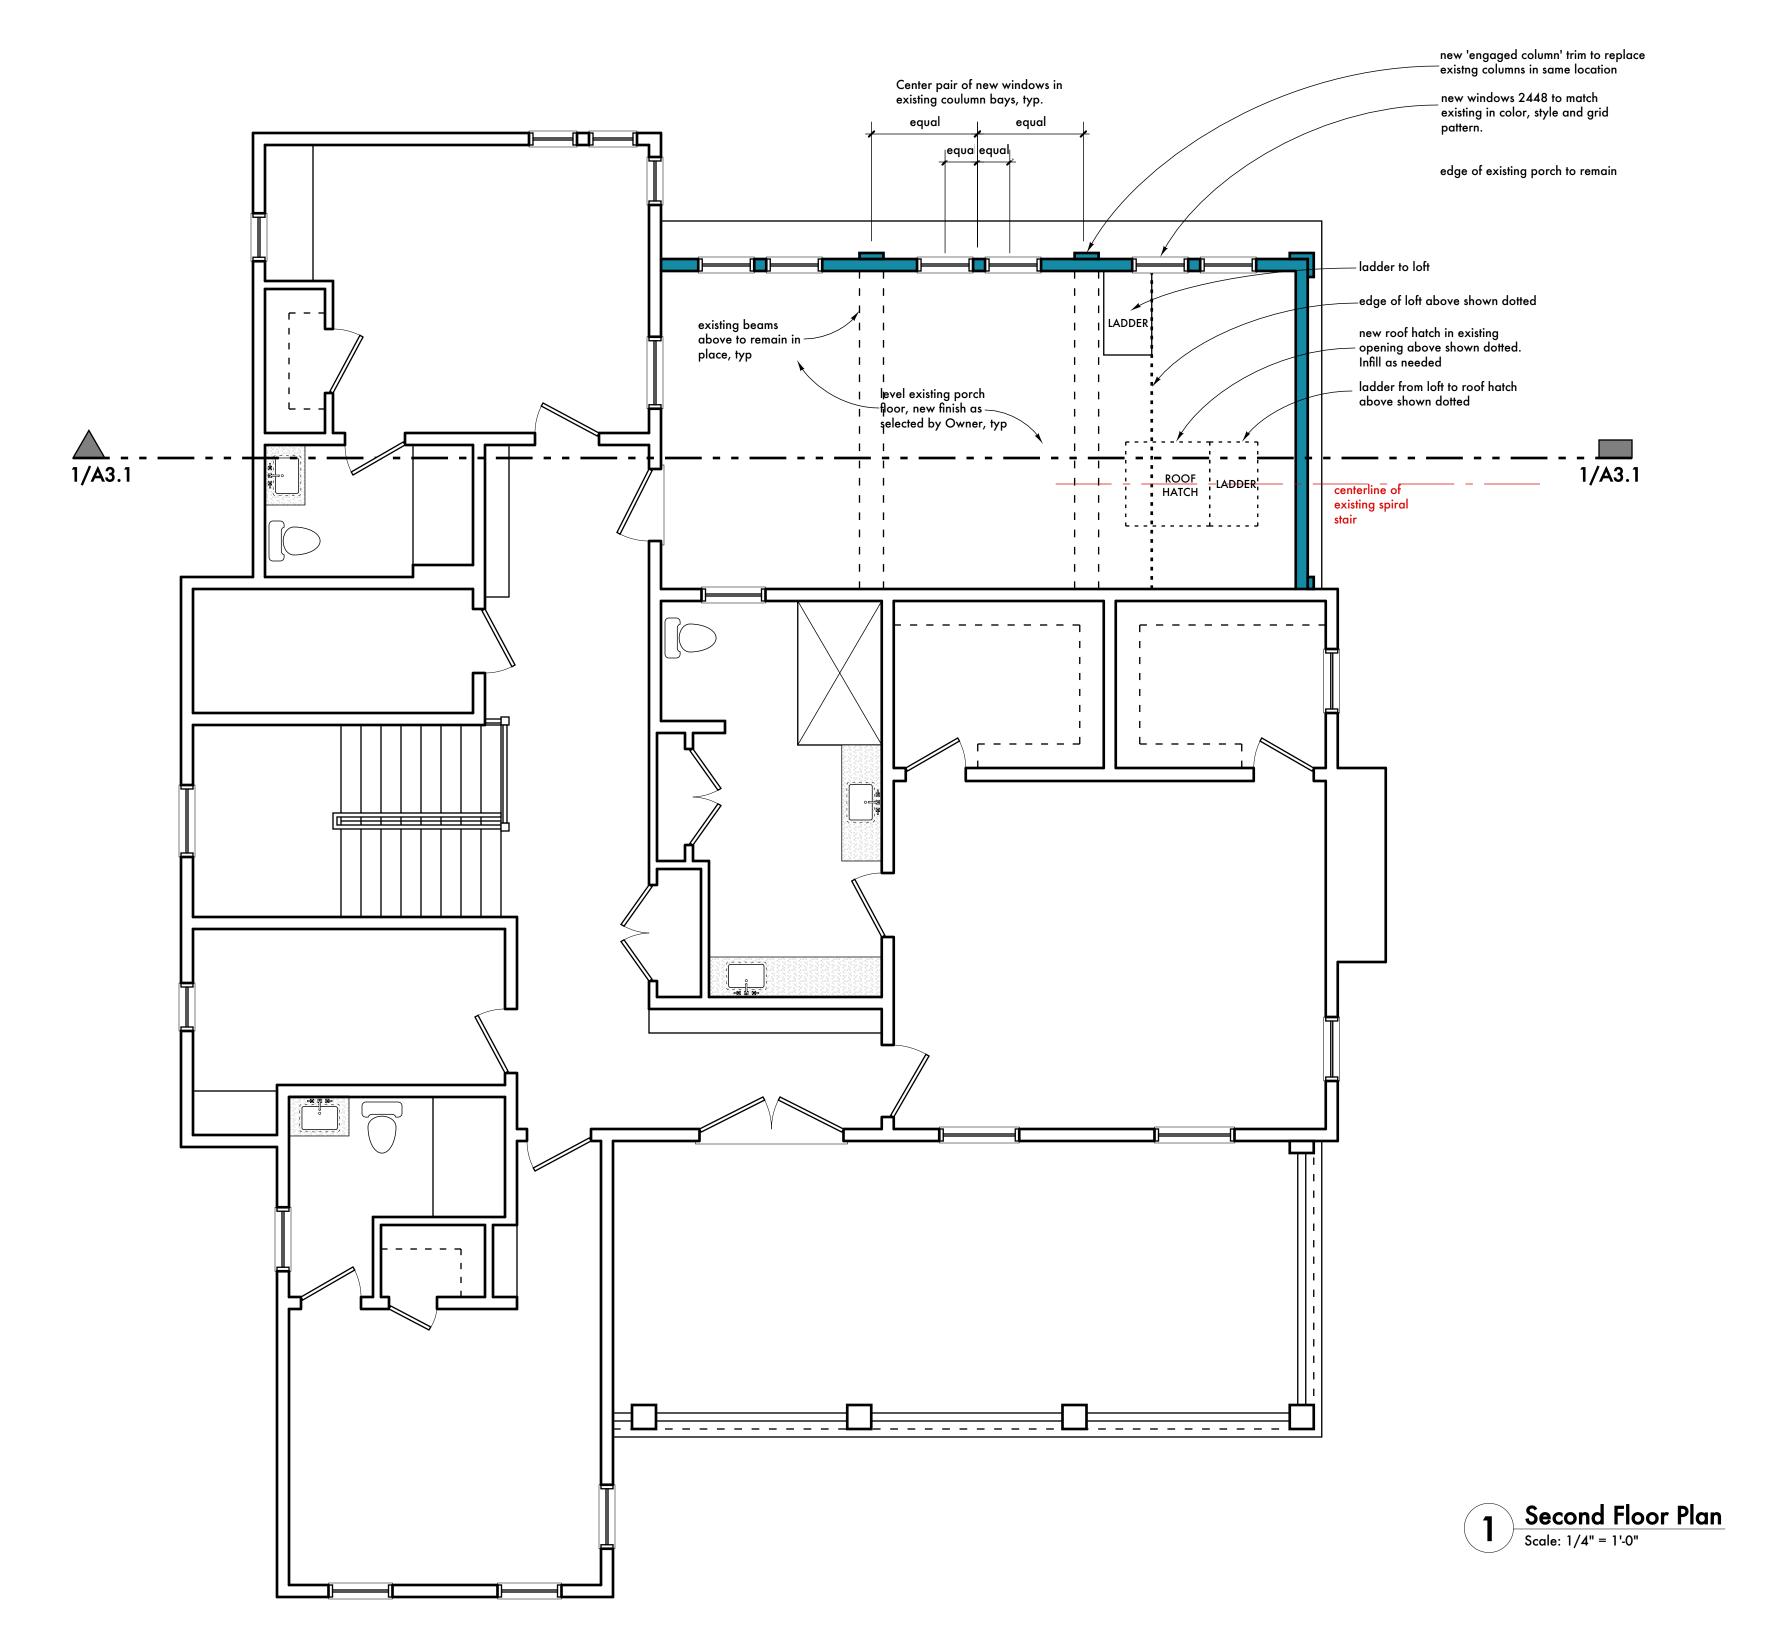

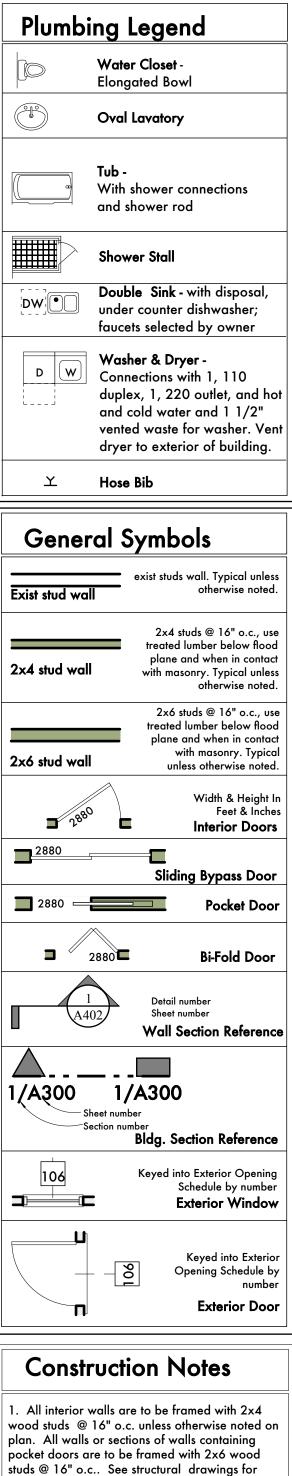

RACHEL BEVERLEY BURTON Summerville \$ No. 8440

SWALLOWTAIL ARCHITECTURE LLC Summerville, SC No. 100760

083122

SWALLOWTAIL ARCHITECTURE, ARCHITECTURE AND INTERIOR DESIGN,

MARSHALL RESIDENCE Infill Second Floor Porch

Plot Date

Checked

Drawn

Drawing Title

1412 Poe Avenue CHARLESTON, SOUTH CAROLINA

10/19/22

plan. All walls or sections of walls containing pocket doors are to be framed with 2x6 wood studs @ 16" o.c.. See structural drawings for additional framing information.

- 2. All interior walls to have sound batt insulation.
- 3. For sizes of structural columns refer to Structural Drawings
- 4. HVAC Contractor to perform heat gain calculations based on volume, amount of glazing, type of glazing, and components which give off heat (A/V components, ice makers, appliances
- 5. All dimensions to face of stud, unless noted
- 6. Exterior windows and doorsas selected by Owner. Refer to Exterior Opening Schedule for
- 7 Exact cabinet layout and configuration by Others. Contractor to ensure window clearance at cabinet locations.
- 8. Set door jambs 6" from corner, where possible.
- 9. Contractor to verify required clearances at
- 10. Install Central Vac system on both floors. Coordinate location of canister, and outlets with

NEW AREA

TOTAL

Exist First and Second Floor Area 3165 370 New Second Floor Area 3535

ALLOWED: 3518.5

ALLOWED RELIEF: 25% or 879.625

Principal Building Square Footage ADDITIONAL AREA ADDED


Request relief for 16.5 SF or .005%

Second Floor Areas

EXISTING HEATED AREA 1579 370


1949

Second Floor

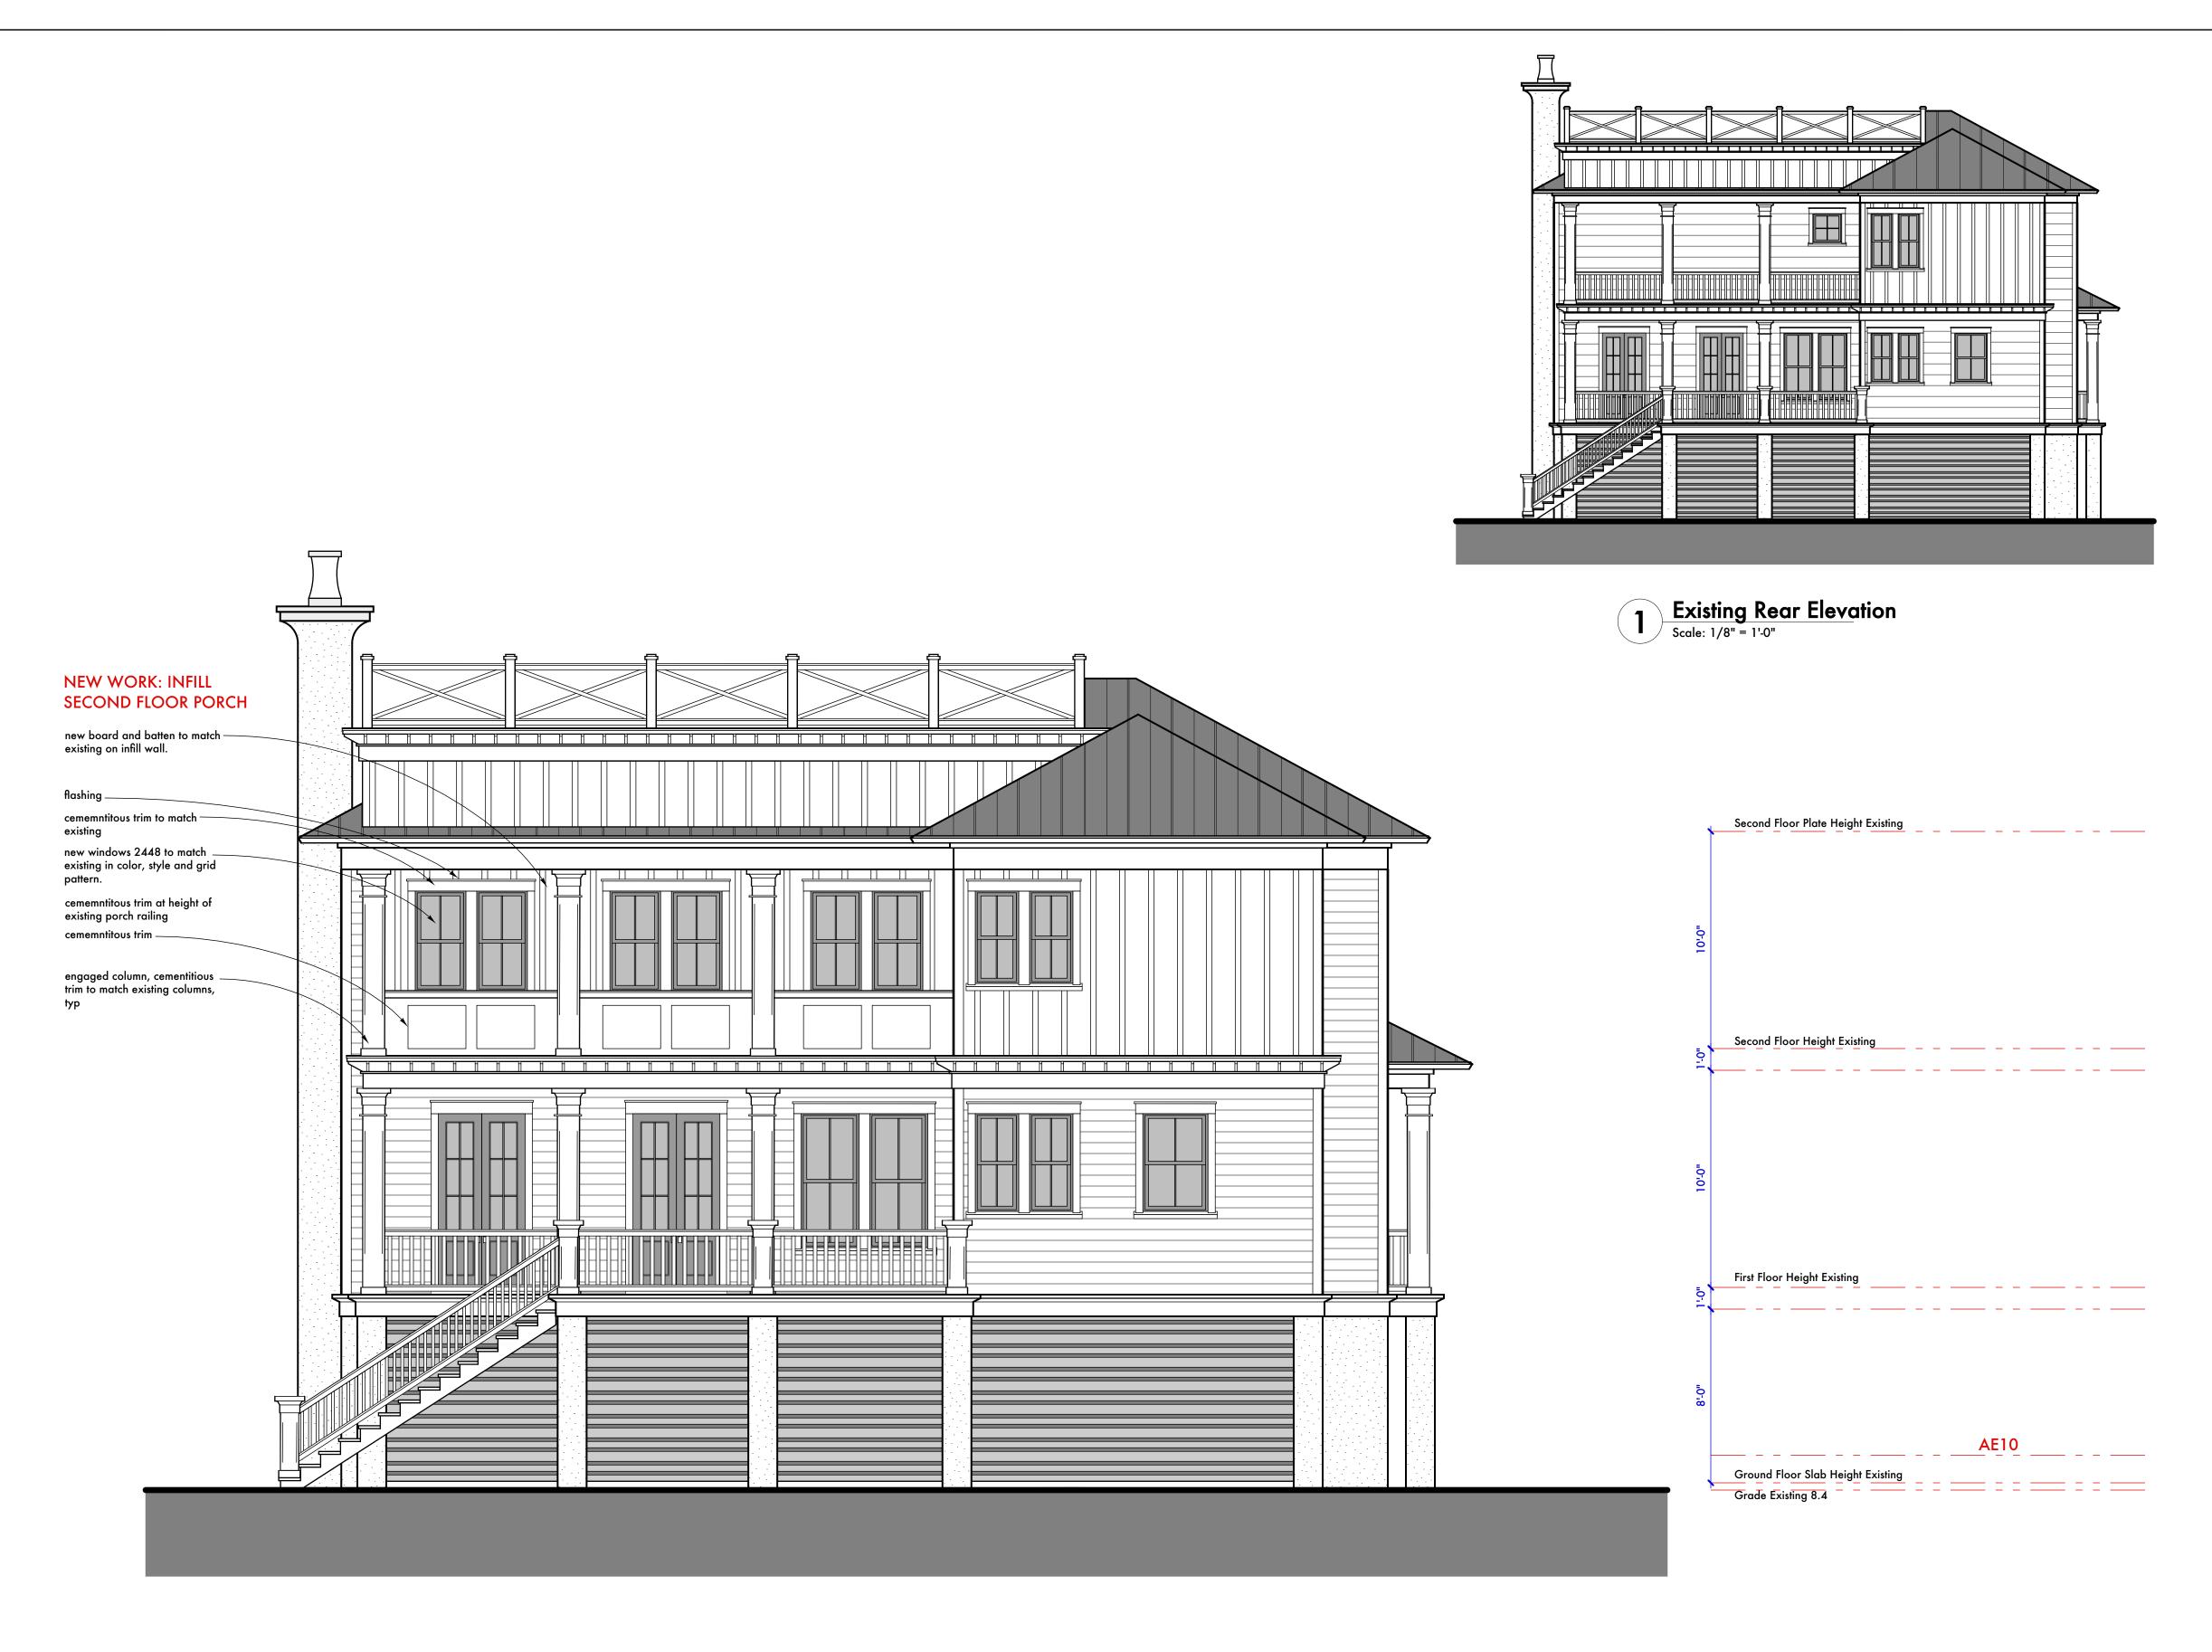

Proposed Rear Elevation with Infill Second FLoor Porch

Scale: 1/4" = 1'-0"

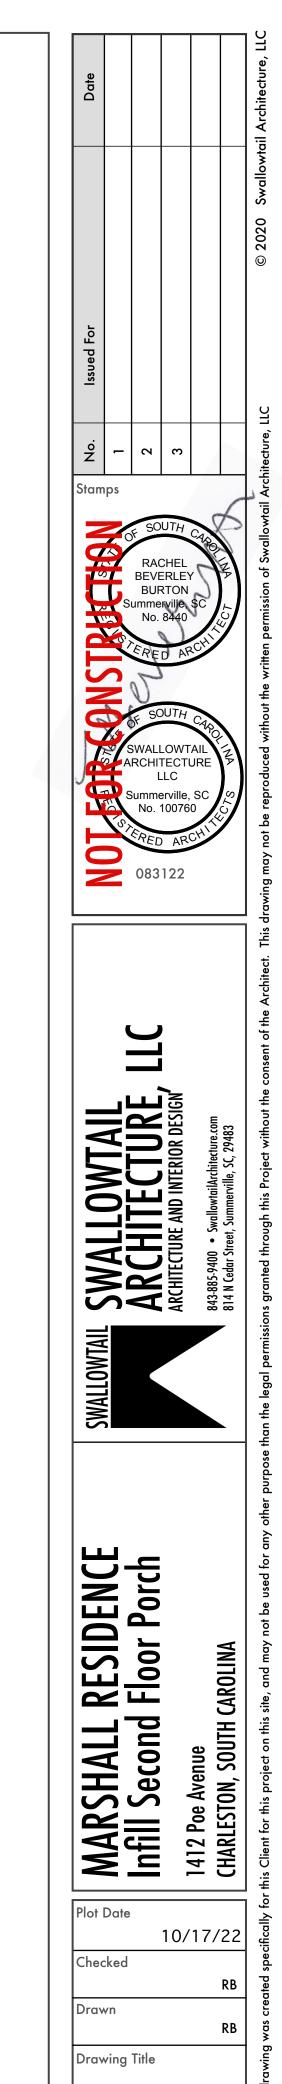


Rear

Elevation




Existing Right SIde Elevation

Scale: 1/8" = 1'-0"

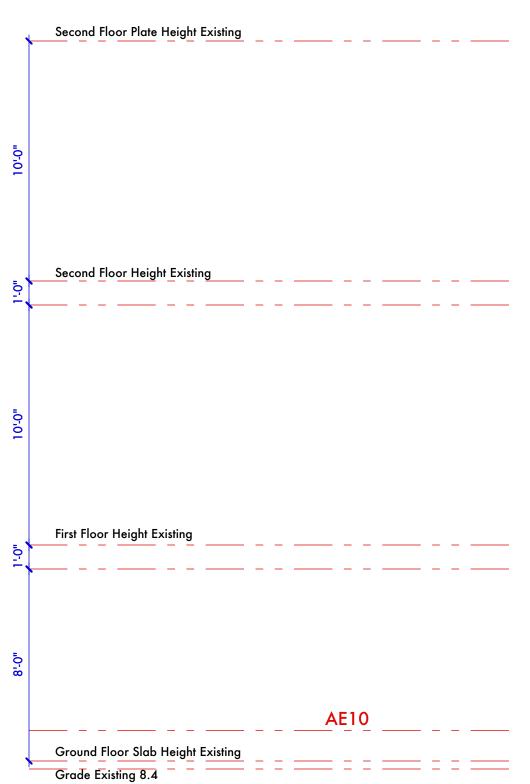

Proposed Right Side Elevation with Infill Second Floor Porch


Scale: 1/4" = 1'-0"

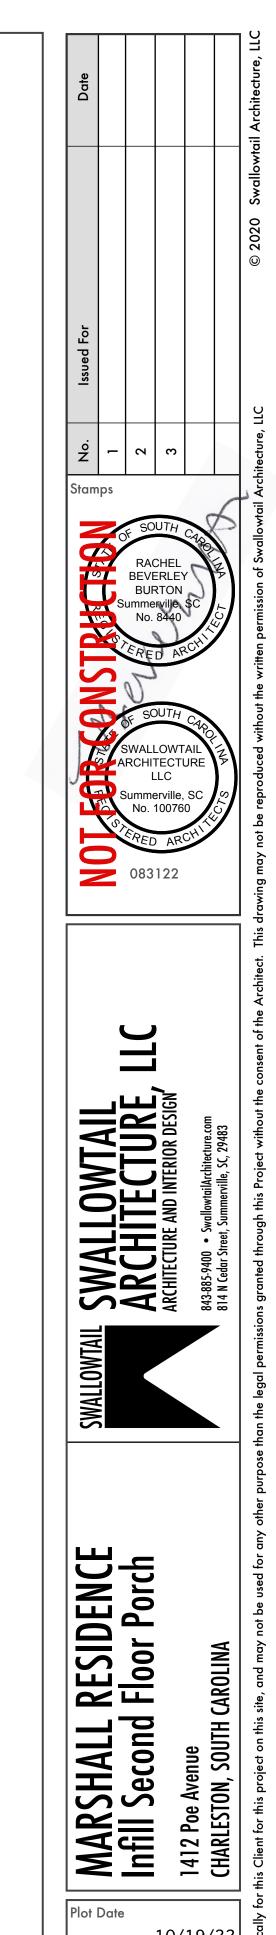


10/19/22 Checked Drawn

Drawing Title


Right Side Elevation

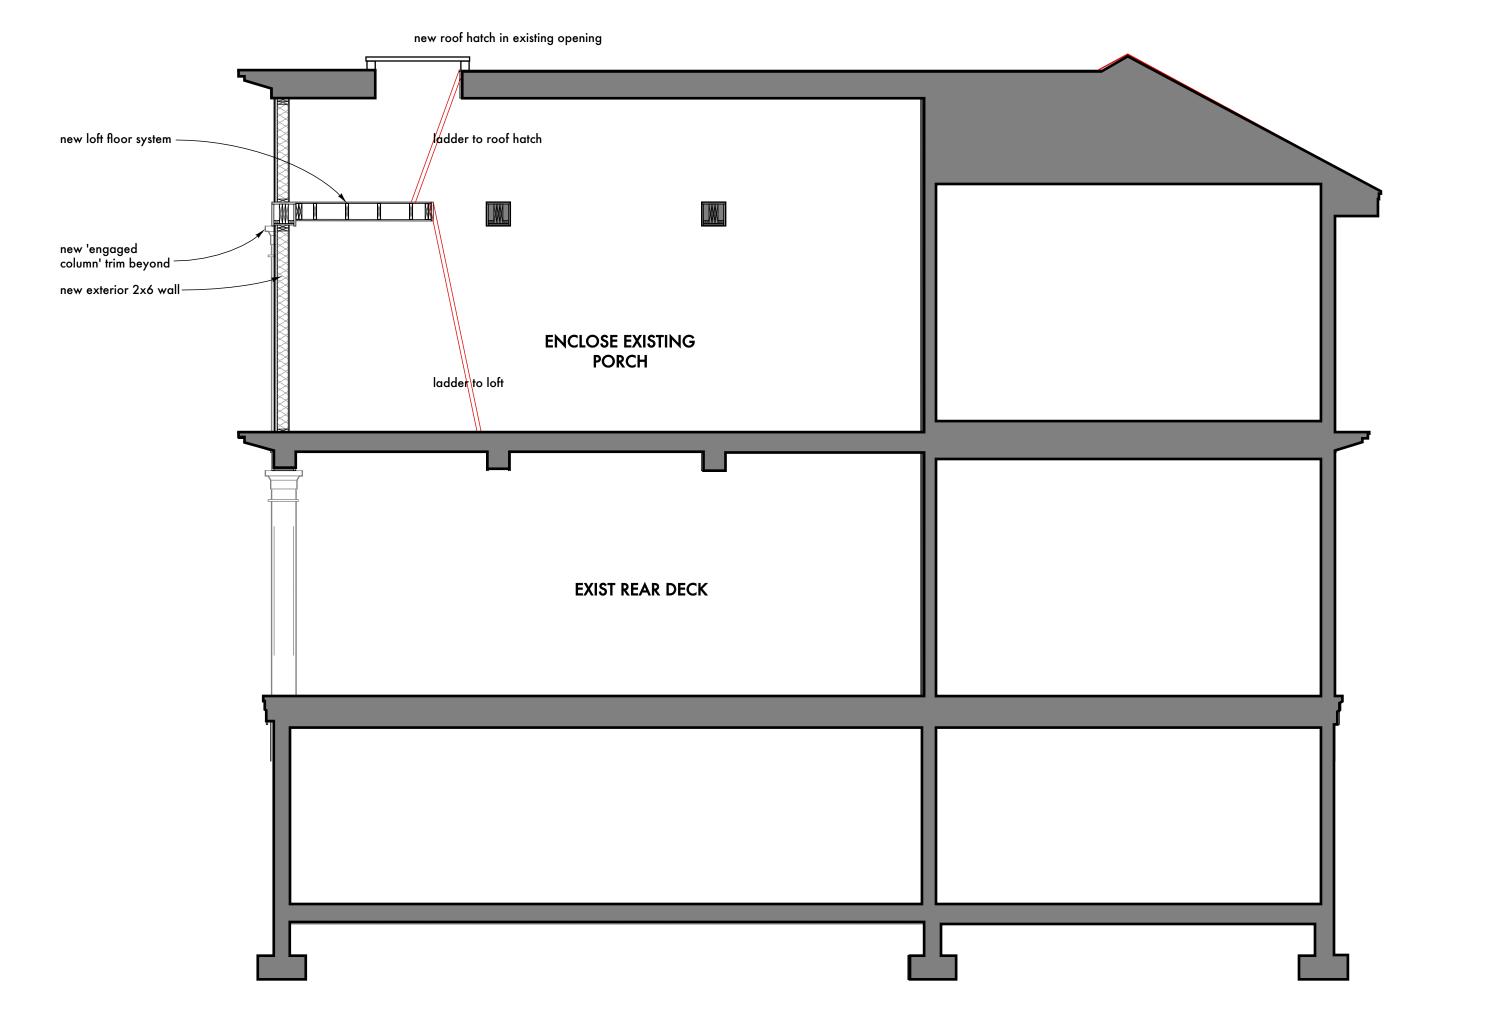

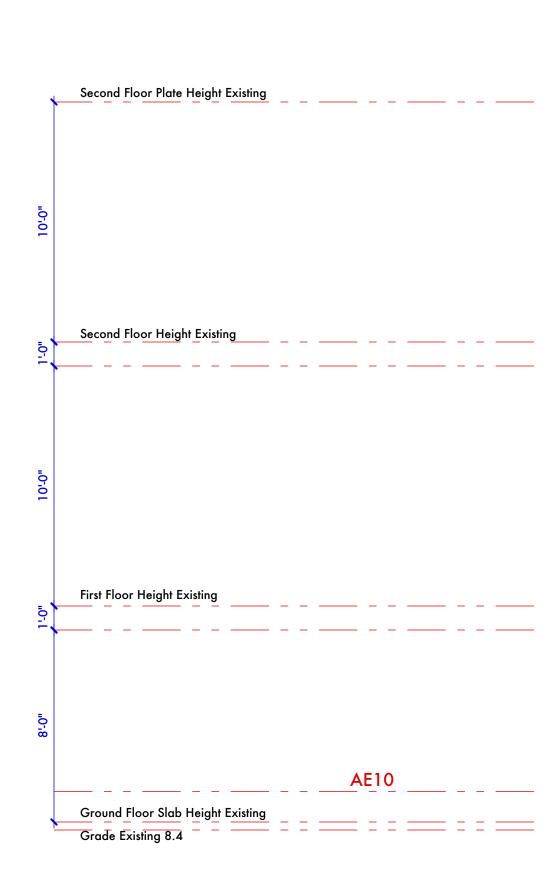

Building Section

Scale: 1/4" = 1'-0"

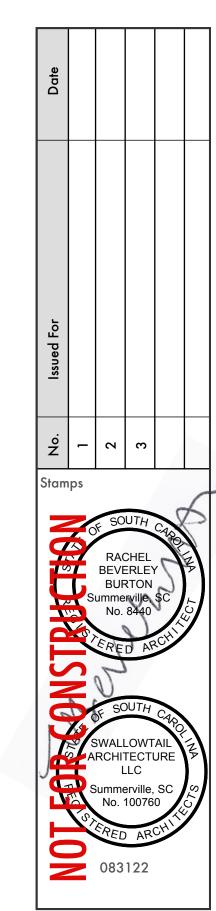


SWALLOWTAIL
SWALLOWTAIL
ARCHITECTURE AND INTERIOR DESIGN
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MARSHALL RESIDENCE Infill Second Floor Porch

Plot Date
10/17/22
Checked
RB
Drawn
RB

Building Section

Prawing No.

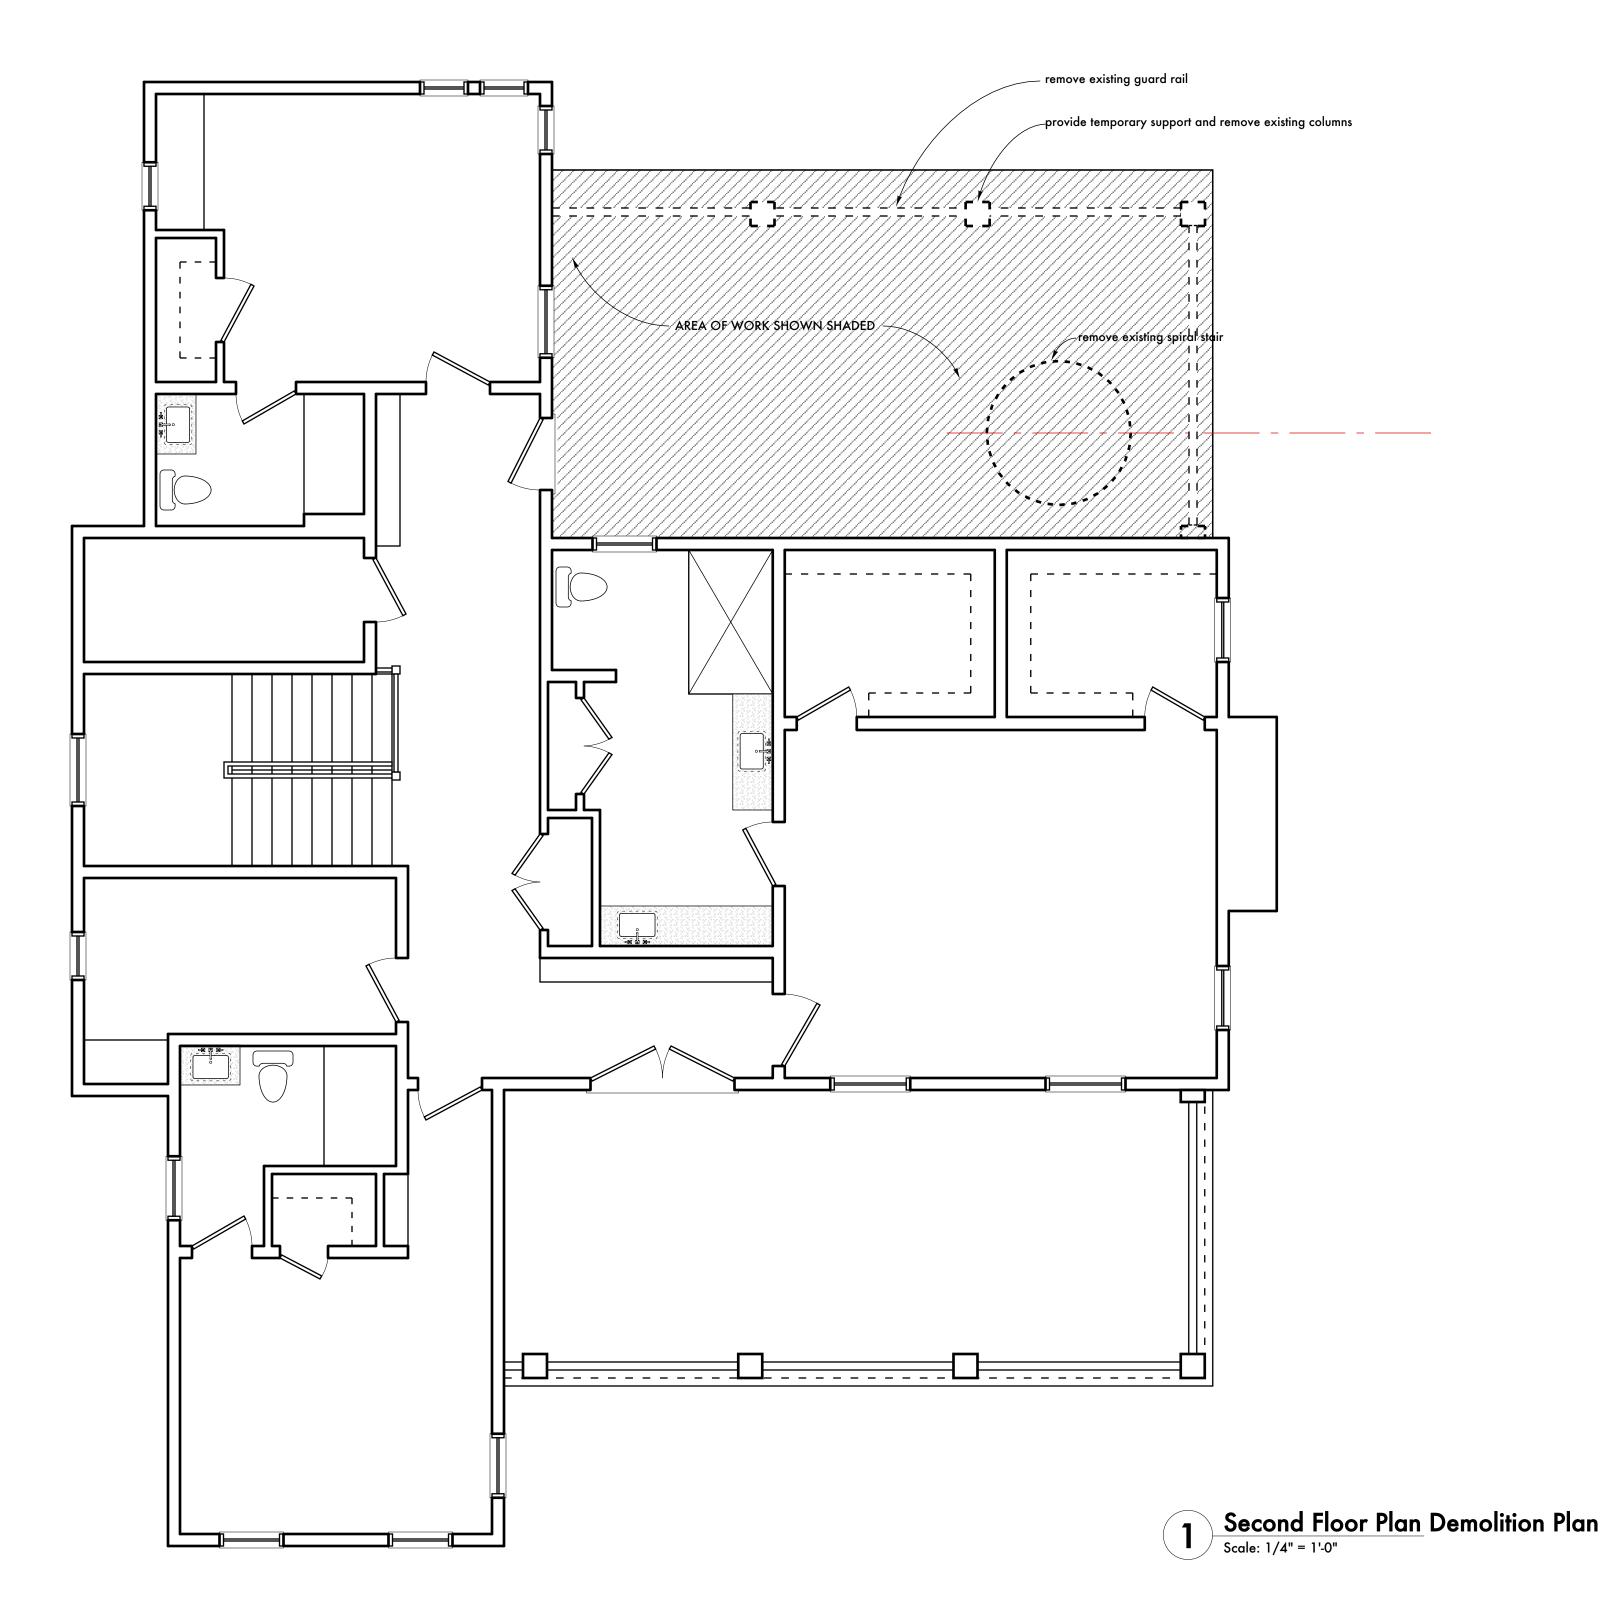

General Demolition Notes

- 1. Before beginning Work at the site, wherever possible, and throughout the course of the Work, inspect and verify the location and condition of every item affected by the Work under this Contract and report any discrepancies to Architect before doing Work related to that being inspected.
- 2. Before beginning Work at the site, inspect the existing house and determine the extent of existing finishes, specialties, casework, equipment, and other items which must be removed and reinstalled in order to perform the Work under this Contract.
- 3. The architectural drawings show principal areas where Work must be accomplished under this Contract. Incidental Work may also be necessary in areas not shown on the architectural drawings due to changes affecting existing mechanical, electrical, plumbing, or other systems. Such incidental Work is also a part of this Contract. Inspect those areas, and ascertain Work needed, and do that Work in accord with the Contract for Construction.
- 5. Remove all doors and windows as indicated.
- 6. Do not drill or cut existing floor joists, beams, columns, or other structural elements, unless specifically indicated. Make openings of proper size for conduits, ducts, pipes, and other items passing through
- 7. Protect existing construction to remain from damage.
- 8. Repair, patch, and finish, or refinish as applicable, to match adjacent existing finishes, those existing surfaces which are damaged or newly exposed during performance of the Work under this
- 9. Where permanent removal of existing millwork, casework, cabinetwork, accessories, equipment or furnishings is required, and previously concealed surfaces are to remain exposed, patch previously concealed surfaces to match adjacent exposed surfaces. Where such surfaces are scheduled to receive new finishes, prepare the surfaces to receive the new
- 10. Where cutting of existing surfaces or removal of existing finishes is required to perform the Work under this Contract and a new finish is not indicated, fill resulting openings and patch the surface after doing the work, and finish to match adjacent existing surfaces.
- 11. Where siding, stucco or other building elements are removed, contractor to inspect existing sheathing and framing for rot and inspect existing nails for rust. Repair or replace in accordance with the Contract for Construction.
- 12. Where conduits, ducts, pipes, and similar items are shown to be installed in existing walls or partitions, neatly chase the walls or partitions, install the items, and patch the walls or partitions to make the installation not discernible in the finished Work.
- 13. Where 'match existing' is indicated, new construction or finishes, as appropriate to the note, shall match the existing in every particular.
- 14. Read demolition drawing in conjunction with first floor plan and Exterior Opening Schedule to locate and size new openings.
- 15. Where exposing exist wood stud wall, Builder to evaluate condition of existing framing, and in consultation with Building Inspector and Architect/Engineer, determine extent of work required to patch and repair. If any supplemental support is required, extent of work to be determined in consultation with Architect/Engineer.
- 16. Where exposing exist. roof joists, Builder to evaluate condition of existing joists, and in consultation with Building Inspector and Architect/Engineer, determine extent of work required to patch and repair. If any supplemental support is required, extent of work to be determined in consultation with Architect/Engineer
- 17. Where exposing existing roof sheathing, Builder to evaluate condition of existing sheathing, and in consultation with Building Inspector and Architect/Engineer, determine extent of work required to patch and repair. If any supplemental support is required, extent of work to be determined in consultation with Architect/Engineer.
- 18. Where exposing exist floor framing, Builder to evaluate condition of existing wall, and in consultation with Architect/Engineer, determine extent of work required to patch and repair. If any supplemental support is required, extent of work to be determined in consultation with Architect/Engineer.
- 19. Where exposing exist. foundation and piers, Builder to evaluate condition of existing, and in consultation with Architect/Engineer, determine extent of work required to patch and repair. If any supplemental support is required, extent of work to be determined in consultation with Architect/Engineer.
- 20. Where exposing existing wall sheathing Builder to evaluate existing sheathing in consultation with Architect/Engineer and determine extent of work required to patch and repair.

Demolition Legend

Existing construction to be removed

Existing construction to remain

RACHEL **BEVERLEY**

SWALLOWTAIL ARCHITECTURE, ARCHITECTURE AND INTERIOR DESIGN



RESIDENCE Floor Porch MARSHALL F Infill Second I

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Second Floor Demo Plan

Drawing No.